

2023 FIRST AVENUE **ROADWAY REPAIRS** FOR BID

CITY OF KENAI





LOCATION MAP



DRAWING INDEX

<u>DRAWING</u>	SHEET
TITLE SHEET AND LOCATION MAP	C1
LEGEND, SURVEY CONTROL, AND NOTES	C2
SITE PLAN AND DAMAGE REGION PHOTOS	C3
TYPICAL SECTIONS AND DETAILS	C4
TYPICAL SECTIONS AND DETAILS	C5
TYPICAL SECTIONS AND DETAILS	C6







2022030.3

DRAWN BY:

CHECKED BY: MJD/MZD

DATE: 5/12/2023 VERT.

NOTED SHEET: C1

1 of 6

LEGEND

EXISTING (E)	PROPOSED (P)		AC	ASPHALT CONCRETE, ACRE	MIN	MINIMUM
EXISTING (E)	PROPOSED (F)		ADA	AMERICAN DISABILITIES ACT	MKR	MARKER POST
		CENTERLINE ROAD	ALUM	ALUMINUM	MON	MONUMENT
100		CONTOUR LINES	APPROX	APPROXIMATE	N	NORTH
			AVG	AVERAGE BUILDING	NFS	NON FROST SUSCEPTIBLE
		EDGE OF PAVEMENT	BLDG BOP	BOTTOM OF PIPE	NTS OC	NOT TO SCALE
		EDGE OF R.O.W.	BVCE	BEGIN VERTICAL CURVE	OFF	ON CENTER OFFSET
		LDGL OF N.O.W.	BVCE	ELEVATION	OHE	OVERHEAD ELECTRIC
~~~~		TREELINE	BVCS	BEGIN VERTICAL CURVE	PI	POINT OF INTERSECTION
— UGC —		UTILITY - COMMUNICATION	2.00	STATION	PL	PROPERTY LINE
			C.O.	CLEANOUT	PP	POWER POLE
OHE		UTILITY - ELECTRIC (OVERHEAD)	CIP	CAST IRON PIPE	PT	POINT
UGE		UTILITY - ELECTRIC (UNDERGROUND)	CL	CENTER LINE, CLASS	PVI	POINT OF VERTICAL
OOL		,	CMP	CORRUGATED METAL PIPE		INTERSECTION
		UTILITY - GAS	CNTR	CENTER	PVMT	PAVEMENT
— w —		UTILITY - WATER	CONC	CONCRETE	R	RADIUS, RECORD
**			CP	CONTROL POINT	REQ'D	REQUIRED
— ss —		UTILITY - SEWER	DIA	DIAMETER	RG	RAIN GARDEN
		COMMUNICATION PEDESTAL	DW	DRIVEWAY	ROW	RIGHT-OF-WAY
		COMMONICATION FEDESTAL	DWG	DRAWING	S	SOUTH
•		CONTROL POINT	E EA	EAST, ELECTRIC	S/W	SIDEWALK
		ELECTRICAL TRANSFORMER	EG	EACH EXISTING GROUND	SW	SWALE
		ELECTRICAL TRANSFORMER	EL,ELEV	ELEVATION	SH	SHOULDER
A		HYDRANT	EOP	END OF PROJECT	SS	SANITARY SEWER/SEWER
		POWER POLE	EP	EDGE OF PAVEMENT	661.6	SERVICE
Ø		POWER POLE	ESMT	EASEMENT	SSLS	SANITARY SEWER LIFT STATION
0		SANITARY SEWER MANHOLE	EXIST	EXISTING	SSMH	SANITARY SEWER
$\oplus$		TEST HOLE LOCATION	FF	FINISH FLOOR	JUNIT	MANHOLE
			FG	FINISH GRADE	STA	STATION
⊗		VALVE BOX	FT	FOOT, FEET	TBC	TOP BACK OF CURB
			F&I	FURNISH AND INSTALL	TBM	TEMPORARY BENCHMARK
		ASPHALT PAVEMENT	GD	GROUND	TC	TOP OF CONCRETE
			GR	GRADE	TP	TEST PIT
		DEMO AND REPLACE CURB.	HYD INV	HYDRANT INVERT	TYP	TYPICAL
		GUTTER, SIDEWALK, AND ASPHALT	INV	LENGTH	UGC	UNDERGROUND COMMUNICATION
		PAVEMENT WITHIN CITY ROW	LF	LINEAR FEET	UGE	UNDERGROUND ELECTRIC
		TATEMENT WITHIN OHT NOW	LT	LEFT	VB	VALVE BOX
		DEMO AND REPLACE	LVC	LENGTH OF VERTICAL CURVE	W	WATER, WEST
		ASPHALT PAVEMENT WITHIN	MAX	MAXIMUM	WS	WATER SERVICE
		ADOT ROW	ME	MATCH EXISTING		
			-			

#### **GENERAL NOTES**

- 1. DRAWINGS BASED ON OF TOPOGRAPHIC SURVEY BY PENINSULA SURVEYING, LLC, DATED JUNE 9, 2022.
- 2. LOCATION OF UNDERGROUND UTILITIES ARE APPROXIMATE. ACTUAL DEPTH, NUMBER AND LOCATION UNKNOWN. BURIED UTILITIES OTHER THAN THOSE SHOWN ON THE PLANS MAY BE PRESENT. THE CONTRACTOR SHALL BE RESPONSIBLE FOR LOCATION, IDENTIFYING, AND WORKING AROUND ALL UTILITIES WITHIN THE PROJECT LIMITS AT NO ADDITIONAL COST TO THE OWNER. CALL FOR LOCATES PRIOR TO EXCAVATION, ALASKA DIGLINE 1-800-478-3121. THE CITY OF KENAI DOES NOT PARTICIPATE IN THE ALASKA DIGLINE. CONTRACTOR SHALL CONTACT CITY OF KENAI PUBLIC WORKS AT 907-283-8236 FOR WATER/SEWER/STREET LIGHT UTILITY LOCATES.
- 3. THE FOLLOWING ALASKA STATUTES APPLY TO WORK NEAR OVERHEAD ELECTRIC LINES: AS 18.60.670 PROHIBITION AGAINST PLACEMENT OF EQUIPMENT NEAR ELECTRICAL LINE AND
  - (1) PLACE ANY TYPE OF TOOL, EQUIPMENT, MACHINERY, OR MATERIAL THAT IS CAPABLE OF LATERAL, VERTICAL, OR SWINGING MOTION, WITHIN 10 FEET OF A HIGH VOLTAGE OVERHEAD ELECTRICAL LINE OR CONDUCTOR.
  - (2) STORE, OPERATE, ERECT, MAINTAIN, MOVE, OR TRANSPORT TOOLS, MACHINERY, EQUIPMENT, SUPPLIES, MATERIALS, APPARATUS, BUILDINGS, OR OTHER STRUCTURES WITHIN 10 FEET OF A HIGH VOLTAGE OVERHEAD ELECTRICAL LINE OR CONDUCTOR.
  - AS 18.60.680 ANY WORK WITHIN MINIMUM DISTANCE STATED ABOVE SHALL REQUIRE CONTACT WITH HEA TO INSTALL TEMPORARY MECHANICAL BARRIERS. TEMPORARY DE-ENERGIZATION AND GROUNDING, OR TEMPORARY RAISING OF CONDUCTORS.
- 4. IF NOT DETAILED IN THESE DRAWINGS AND SPECIFICATIONS, ALL APPLICABLE CONSTRUCTION SHALL BE BUILT IN ACCORDANCE WITH MUNICIPALITY OF ANCHORAGE STANDARD SPECIFICATIONS (M.A.S.S.), LATEST EDITION. REPLACE "AWWU" WITH "CITY OF KENAI" THROUGHOUT SPECIFICATIONS. PROJECT DRAWINGS AND PROJECT SPECIFICATIONS TAKE PRECEDENCE OVER M.A.S.S.
- 5. CONTRACTOR IS REQUIRED TO FIND ALL PROPERTY PINS/MONUMENTS WITHIN PROJECT AREA AND PROTECT OR REPLACE AFTER CONSTRUCTION IS COMPLETE.
- 6. SEED ALL AREAS DISTURBED BY CONSTRUCTION PER M.A.S.S., LATEST EDITION.
- 7. CONTOURS SHOWN ON THE PLANS ARE FOR INFORMATIONAL PURPOSES AND SHOULD ONLY BE USED AS A REPRESENTATION OF EXISTING GRADES. SURVEYED ELEVATIONS ARE SHOWN ON THE ROAD PROFILES.
- 8. CONTRACTOR SHALL ADHERE TO LOCAL REQUIREMENTS FOR NOISE, HOURS OF OPERATION, AND DUST CONTROL.
- 9. TRAFFIC MARKINGS:
  - -PROVIDE 4" DOUBLE SOLID YELLOW STRIP AT CENTERLINE OF ROAD

TRACT A TBM 4	WAREHOUSE SUBD LOT 2	WAREHOUSE SUBD LOT 3	LOT 2	LOT 3	LOT 170	15	SPRUCE CREEK SUBD LOT 3 SPRUCE CREEK SUBD LOT 4
CP 7—  KENAI SPUR HIM		DT 21 LOT	FIRST AVE	LOT 19	LOT 18	-	CP 3

GRAPHIC SCALE: 1"=60' (22X34), 1"=120' (11X17)

CONTROL POINTS						
POINT	DESCRIPTION	NORTHING	EASTING	ELEVATION		
CP 1	REBAR WITH RED PLASTIC CAP	2398644.17	1411885.55	107.71		
CP 2	REBAR WITH YELLOW PLASTIC CAP	2398807.01	1412167.35	108.74		
CP 3	REBAR WITH RED PLASTIC CAP	2398740.12	1412566.02	108.27		
CP 6	2" ALUMINUM MONUMENT	2398767.74	1412496.76	107.95		
CP 7	2" ALUMINUM MONUMENT	2398780.36	1411836.97	105.89		
TBM 4	SPIKE IN POWER POLE	2398816	1411804	109.21		
TBM 5	NORTH BOLT ON UPPER HYDRANT FLANGE	2398813	1412523	111.19		





ENGINI CIVIL



FIRST AVENUE ROADWAY REPAIRS
CITY OF KENAI
KENAI, ALASKA
SURVEY CONTROL, AND NOTES

PROJECT NO. 2022030.3

DRAWN BY: GTP


**FIRST** 


CHECKED BY: MJD/MZD


DATE: 5/12/2023 SCALES: NOTED HORIZ. NOTED VERT. NOTED


SHEET:


2 OF 6

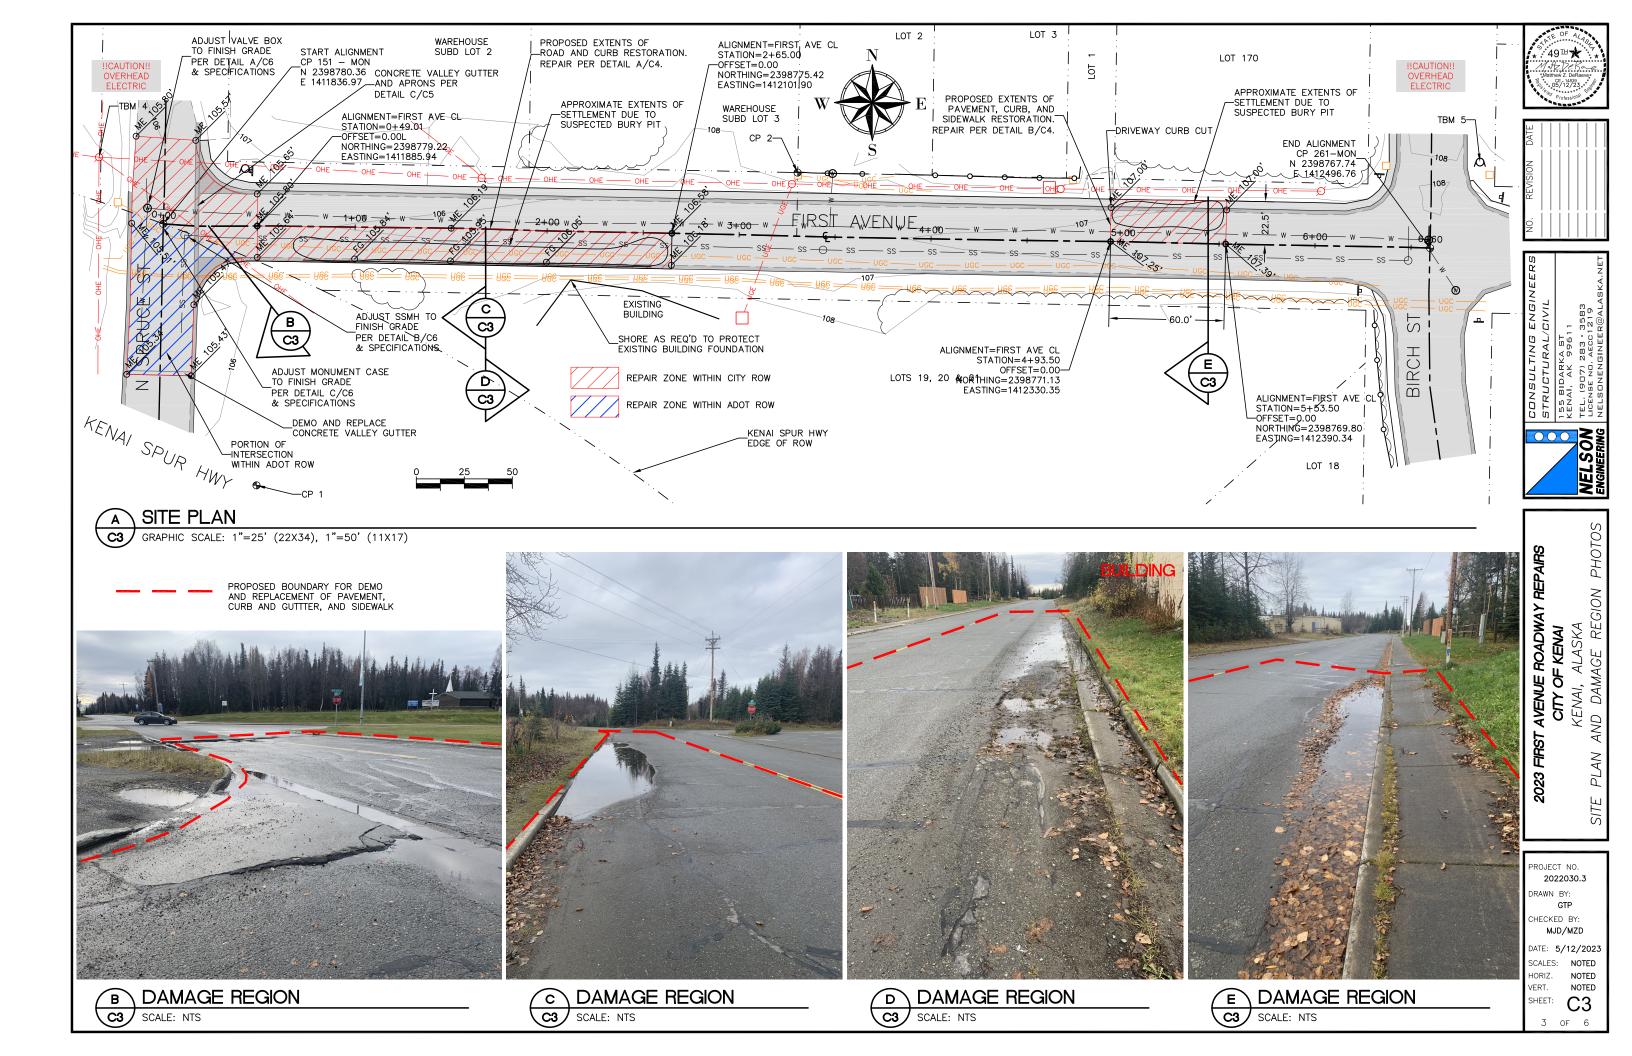


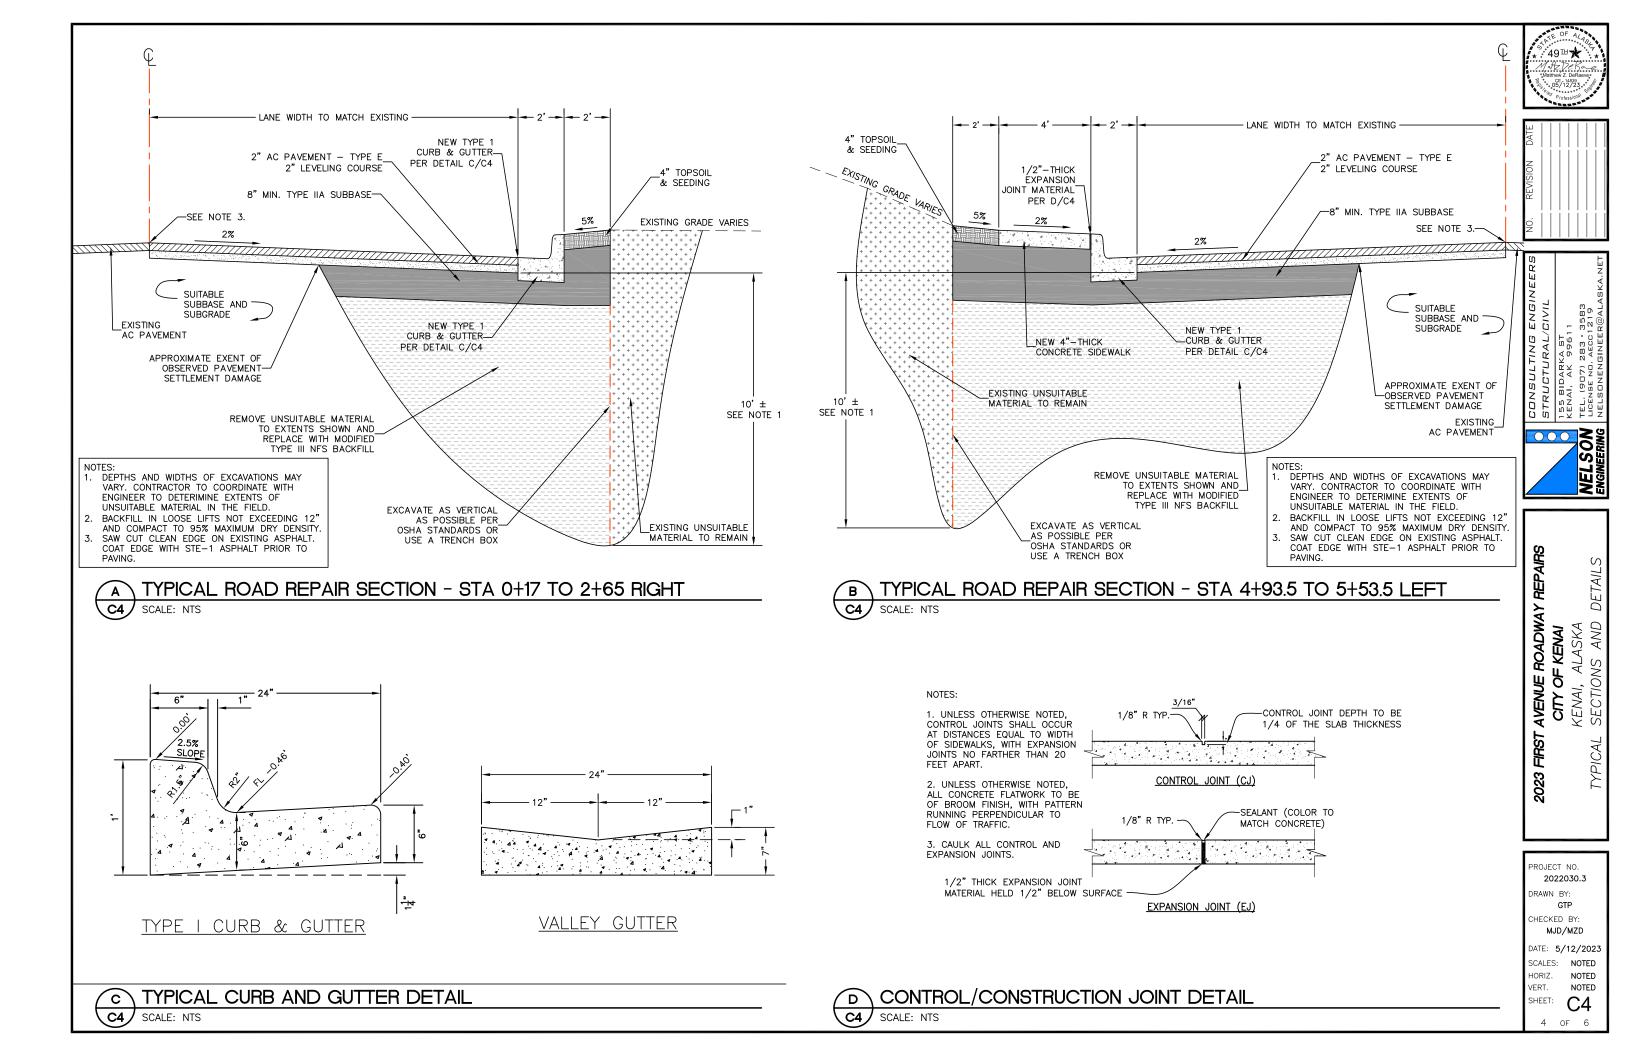

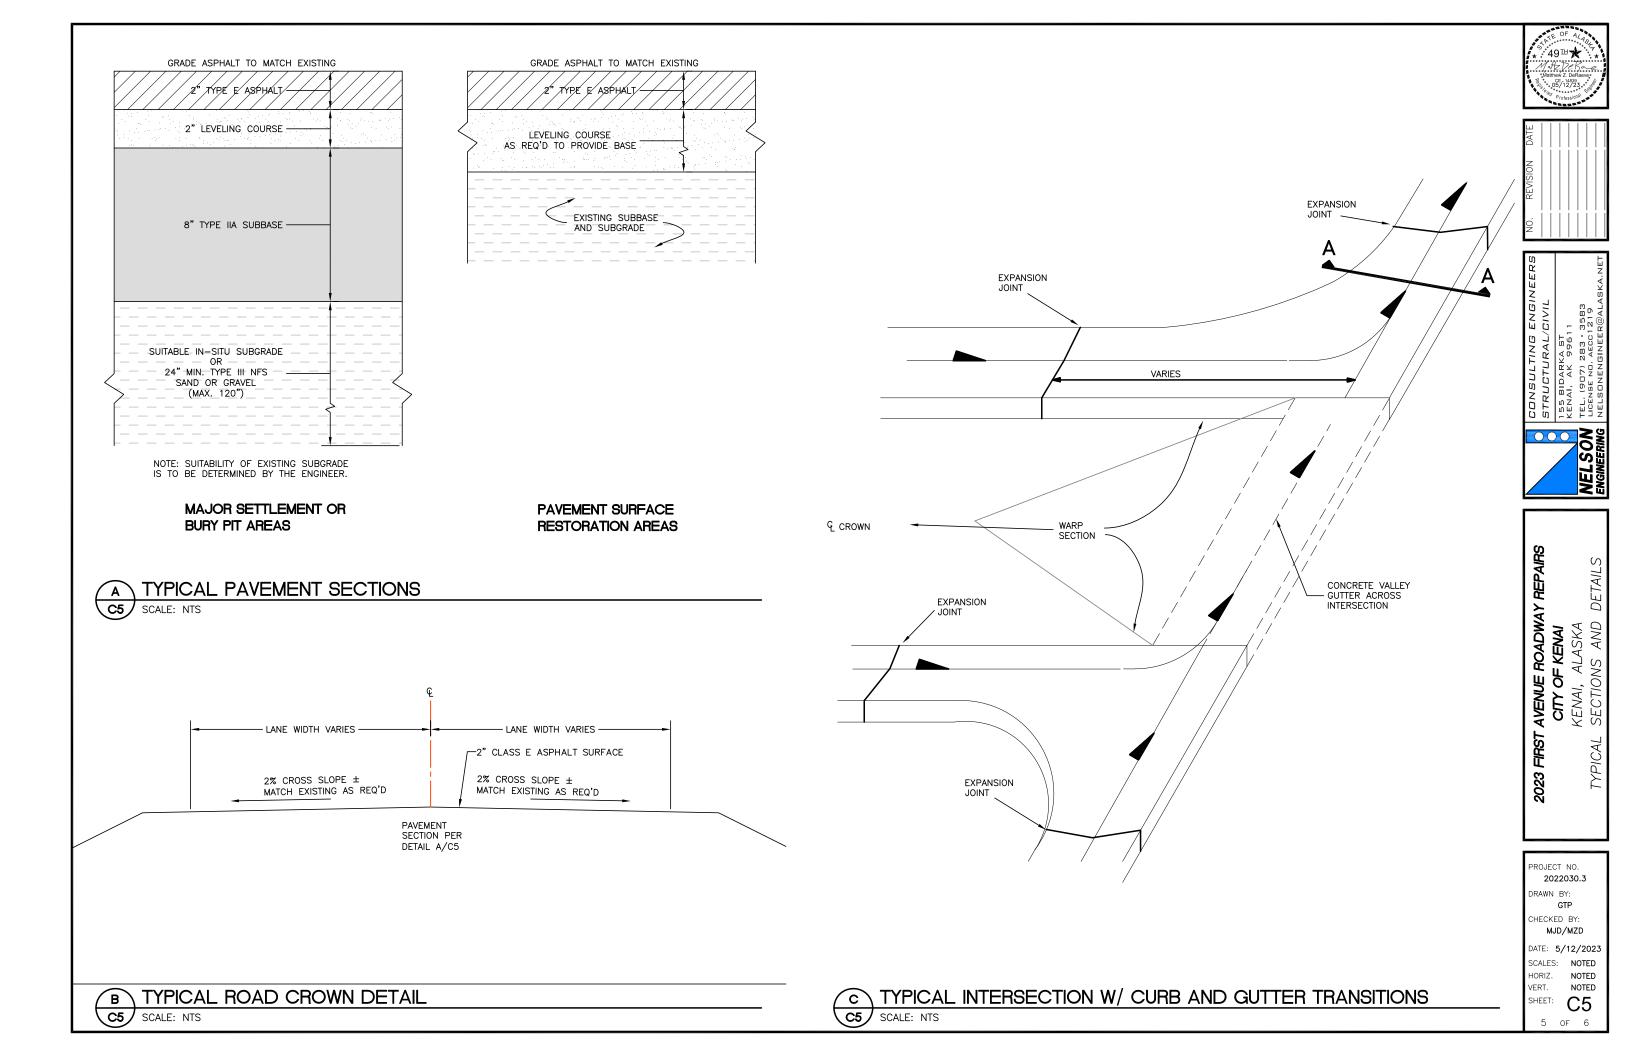

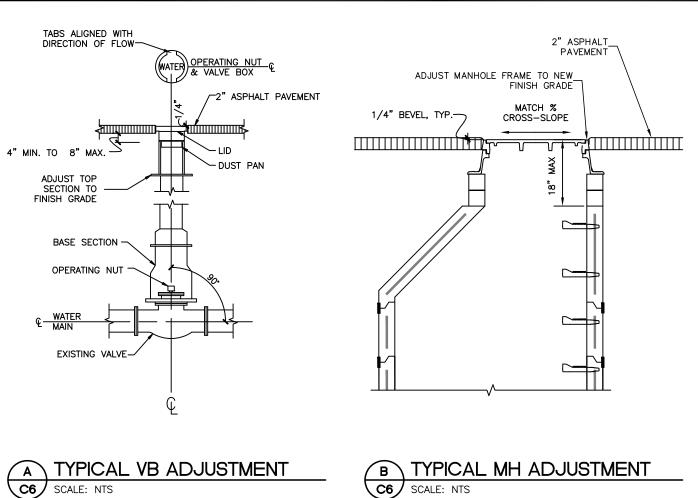

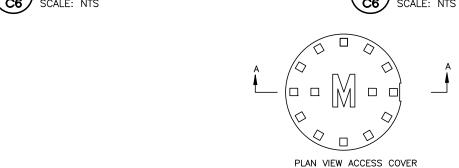

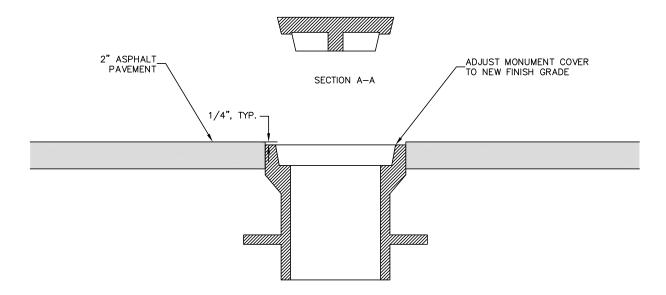

TYPICAL MONUMENT ADJUSTMENT <u>C6</u>

SCALE: NTS







2023 FIRST AVENUE ROADWAY REPAIRS
CITY OF KENAI
KENAI, ALASKA
TYPICAL SECTIONS AND DETAILS

PROJECT NO. 2022030.3

DRAWN BY: GTP

CHECKED BY: MJD/MZD

DATE: 5/12/2023 SCALES: NOTED

HORIZ. NOTED VERT. NOTED SHEET:

C6 6 of 6